		OF NA	OF UTAH NATURAL RESOURCES AMENDED REPORT L, GAS AND MINING											
		APPI	ICATION	FOR P	ERMIT TO DRILL	-				1. WELL NAME and NUMBER Condor Trust 12-18-4-1W				
2. TYPE OF WORK DRILL NEW WELL REENTER P&A WELL DEEPEN WELL								3. FIELD OR WILDCAT UNDESIGNATED						
4. TYPE	OF WELL	Oil \	Well (Coalbed	Methane Well: NO					5. UNIT or COMMU	NITIZA	TION AGR	EEMENT	NAME
6. NAME	OF OPERATOR		NEWFIELD PR	ODUCT	TON COMPANY					7. OPERATOR PHO		46-4825		
8. ADDRESS OF OPERATOR Rt 3 Box 3630 , Myton, UT, 84052									9. OPERATOR E-MA	\IL	newfield.co	m		
	ERAL LEASE N AL, INDIAN, OI			- 1	11. MINERAL OWNE	RSHIP DIAN (STATE () FEE(<u> </u>	12. SURFACE OWN	ERSHIP DIAN (STAT	<u> </u>	FEE (📵)
13. NAM	E OF SURFACE	OWNER (if box 1		vid R. E	Batty			. ,	_	14. SURFACE OWN	ER PHO	NE (if box	12 = 'fe	ee')
15. ADD	RESS OF SURF	ACE OWNER (if b	ox 12 = 'fee	')	Vernal, UT 84078					16. SURFACE OWN	ER E-M	AIL (if box	12 = 'f	ee')
	(AN ALLOTTEE 2 = 'INDIAN')	OR TRIBE NAME			18. INTEND TO COM		E PRODUCTIO	ON FROM	1	19. SLANT				
(II box 1	Z = INDIAN)				YES (Submit C	Comming	ling Application	n) NO [•	VERTICAL DIF	RECTION	IAL 🔵	HORIZON	NTAL 🔵
20. LOCATION OF WELL FO			FOO	TAGES	QT	R-QTR	SECTI	ION	TOWNSHIP	R	ANGE	МЕ	RIDIAN	
LOCATI	ON AT SURFA	CE	1	980 FSL	_ 571 FWL	N/	wsw	18		4.0 S	:	1.0 W		U
Top of Uppermost Producing Zone 1980 FS			980 FSL	SL 571 FWL N		WSW	18	4.0 S			1.0 W		U	
At Tota			1				wsw	18		4.0 S		1.0 W		U
21. COUI	21. COUNTY DUCHESNE 22. DISTANCE TO NEARI					57	71			23. NUMBER OF AC		DRILLING 40	3 UNIT	
25. DISTANCE TO NEARE (Applied For Drilling or C					EAREST or Con 12	mpleted)	ME POOL	-	26. PROPOSED DEF	PTH : 7380	TVD: 73	30		
27. ELEV	ATION - GROU			2	28. BOND NUMBER	B001	29. SOURCE OF DRILLING WATER / WATER RIGHTS APPROVAL NUMBER IF APPLICABLE 437478				LICABLE			
_		5182			Hole, Casing,			rmation	<u> </u>		75	7470		
String	Hole Size	Casing Size	Length	Weig	1		Max Mud	Wt.		Cement Sacks Yield Weight				
Surf Prod	12.25 7.875	8.625 5.5	0 - 500 0 - 7380	24. 15.			8.3	-	Prem	Class G nium Lite High Stre	ngth	372	3.26	15.8 11.0
										50/50 Poz	J-	363	1.24	14.3
					A	TTACH	MENTS							
	VERIFY T	HE FOLLOWIN	G ARE ATT	ACHE	D IN ACCORDAN	CE WI	TH THE UTA	AH OIL	AND G	GAS CONSERVATI	ON GE	NERAL I	RULES	
∠ w	ELL PLAT OR	MAP PREPARED B	Y LI <mark>CEN</mark> SEC	SURV	EYOR OR ENGINEER	R	СОМРІ	LETE DRI	ILLING	PLAN				
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NAME M	1andie Crozier				TITLE Regulatory	Tech			PHON	NE 435 646-4825				
SIGNAT	URE				DATE 07/28/2011				EMAI	L mcrozier@newfield.	.com			
	mber assign 013509030				APPROVAL				B	DE GUILLE				
									Pe	ermit Manager				

NEWFIELD PRODUCTION COMPANY CONDOR TRUST 12-18-4-1W NW/SW SECTION 18, T4S, R1W DUCHESNE COUNTY, UTAH

TEN POINT DRILLING PROGRAM

1. **GEOLOGIC SURFACE FORMATION:**

Uinta formation of Upper Eocene Age

2. ESTIMATED TOPS OF IMPORTANT GEOLOGIC MARKERS:

0' - 2,095'Uinta Green River 2,095 Wasatch 7,105 **Proposed TD** 7,380'

3. ESTIMATED DEPTHS OF ANTICIPATED WATER, OIL, GAS OR MINERALS:

2,095' - 7,105'Green River Formation (Oil)

Fresh water may be encountered in the Uinta Formation, but would not be expected below about 350'. All water shows and water bearing geologic units shall be reported to the geologic and engineering staff of the Vernal Office prior to running the next string of casing or before plugging orders are requested. All water shows must be reported within one (1) business day after being encountered.

All usable (<10,000 PPM TDS) water and prospectively valuable minerals (as described by BLM at onsite) encountered during drilling will be recorded by depth and adequately protected. This information shall be reported to the Vernal Office.

Detected water flows shall be sampled, analyzed, and reported to the geologic & engineering staff of the Vernal Office. The office may request additional water samples for further analysis. Usage of the State of Utah form Report of Water Encountered is acceptable, but not required.

The following information is requested for water shows and samples where applicable:

Location & Sampled Interval Date Sampled Flow Rate Temperature Hardness pН Water Classification (State of Utah) Dissolved Calcium (Ca) (mg/l) Dissolved Iron (Fe) (ug/l) Dissolved Sodium (Na) (mg/l) Dissolved Magnesium (Mg) (mg/l) Dissolved Carbonate (CO₃) (mg/l) Dissolved Bicarbonate (NaHCO₃) (mg/l)

Dissolved Sulfate (SO₄) (mg/l) Dissolved Total Solids (TDS) (mg/l)

Dissolved Chloride (Cl) (mg/l)

4. <u>PROPOSED CASING PROGRAM</u>

a. Casing Design: Condor Trust 12-18-4-1W

Size	Interval		Weight	Grade	Coupling	Design Factors			
Size	Тор	Bottom	weigni	Grade	Coupling	Burst	Collapse	Tension	
Surface casing	0'	500'	24.0	J-55	STC	2,950	1,370	244,000	
8-5/8"		300				10.52	8.61	20.33	
Prod casing	2	7 2001	15.5	J-55	1.70	4,810	4,040	217,000	
5-1/2"	0'	7,380'			LTC	2.05	1.72	1.90	

Assumptions:

- 1) Surface casing max anticipated surface press (MASP) = Frac gradient gas gradient
- 2) Prod casing MASP (production mode) = Pore pressure gas gradient
- 3) All collapse calculations assume fully evacuated casing w/ gas gradient
- 4) All tension calculations assume air weight

Frac gradient at surface casing shoe =
Pore pressure at surface casing shoe =
Pore pressure at prod casing shoe =
Rose gradient =

13.0 ppg
8.33 ppg
8.33 ppg
0.115 psi/ft

All casing shall be new or, if used, inspected and tested. Used casing shall meet or exceed API standards for new casing.

All casing strings shall have a minimum of 1 (one) centralizer on each of the bottom three (3) joints.

b. Cementing Design; Condor Trust 12-18-4-1W

Job	Fill	Description	Sacks ft ³	OH Excess*	Weight (ppg)	Yield (ft³/sk)
Surface casing	500'	Class G w/ 2% CaCl	229 268	30%	15.8	1.17
Prod casing Lead	5,380'	Prem Lite II w/ 10% gel + 3% KCl	372 1212	30%	11.0	3.26
Prod casing Tail	2,000'	50/50 Poz w/ 2% gel + 3% KCl	363 451	30%	14.3	1.24

^{*}Actual volume pumped will be 15% over the caliper log

Hole Sizes: A 12-1/4" hole will be drilled for the 8-5/8" surface casing. A 7-7/8" hole will be drilled for the 5-1/2" production casing.

The 8-5/8" surface casing shall in all cases be cemented back to surface. In the event that during the primary surface cementing operation the cement does not circulate to surface, or if the cement level should fall back more than 8 feet from surface, then a remedial surface cementing operation shall be performed to insure adequate isolation and stabilization of the surface casing.

5. <u>MINIMUM SPECIFICATIONS FOR PRESSURE CONTROL</u>:

The operator's minimum specifications for pressure control equipment are as follows:

⁻ Compressive strength of lead cement: 1800 psi @ 24 hours, 2250 psi @ 72 hours

⁻ Compressive strength of tail cement: 2500 psi @ 24 hours

An 8" Double Ram Hydraulic unit with a closing unit will be utilized. Function test of BOP's will be check daily.

Refer to Exhibit C for a diagram of BOP equipment that will be used on this well.

6. TYPE AND CHARACTERISTICS OF THE PROPOSED CIRCULATION MUDS:

From surface to ±500 feet will be drilled with an air/mist system. The air rig is equipped with a 6 ½" blooie line that is straight run and securely anchored. The blooie line is used with a discharge less than 100 ft from the wellbore in order to minimize the well pad size. The blooie line is not equipped with an automatic igniter or continuous pilot light and the compressor is located less than 100 ft from the well bore due to the low possibility of combustion with the air dust mixture. The trailer mounted compressor (capacity of 2000 CFM) has a safety shut-off valve which is located 15 feet from the air rig. A truck with 70 bbls of water is on stand by to be used as kill fluid, if necessary. From about ±500 feet to TD, a fresh water system will be utilized. Clay inhibition and hole stability will be achieved with a KCl substitute additive. This additive will be identified in the APD and reviewed to determine if the reserve pit shall be lined. This fresh water system will typically contain Total Dissolved Solids (TDS) of less than 3000 PPM. Anticipated mud weight is 8.4 lbs/gal. If necessary to control formation fluids or pressure, the system will be weighted with the addition of bentonite gel, and if pressure conditions warrant, with barite

No chromate additives will be used in the mud system on Federal and/or Indian lands without prior BLM approval to ensure adequate protection of fresh aquifers.

No chemicals subject to reporting under SARA Title III in an amount equal to or greater than 10,000 pounds will be used, produced, stored, transported, or disposed of annually in association with the drilling, testing, or completing of this well. Furthermore, no extremely hazardous substances, as defined in 40 CFR 355, in threshold planning quantities, will be used, produced, stored, transported, or disposed of in association with the drilling, testing, or completing of this well.

Hazardous substances specifically listed by the EPA as a hazardous waste or demonstrating a characteristic of a hazardous waste will not be used in drilling, testing, or completion operations.

Newfield Production will **visually** monitor pit levels and flow from the well during drilling operations.

7. AUXILIARY SAFETY EQUIPMENT TO BE USED:

Auxiliary safety equipment will be a Kelly Cock, bit float, and a TIW valve with drill pipe threads.

8. TESTING, LOGGING AND CORING PROGRAMS:

The logging program will consist of a Dual Induction, Gamma Ray and Caliper log from TD to base of surface casing @ 500' +/-, and a Compensated Neutron-Formation Density Log from TD to 3500' +-. A cement bond log will be run from PBTD to cement top. No drill stem testing or coring is planned for this well.

9. ANTICIPATED ABNORMAL PRESSURE OR TEMPERATURE:

No abnormal temperatures or pressures are anticipated. No hydrogen sulfide has been encountered or is known to exist from previous drilling in the area at this depth. Maximum anticipated bottomhole pressure will approximately equal total depth in feet multiplied by a 0.433 psi/foot gradient.

10. <u>ANTICIPATED STARTING DATE AND DURATION OF THE OPERATIONS:</u>


It is anticipated that the drilling operations will commence the third quarter of 2011, and take approximately seven (7) days from spud to rig release.



T4S, R1W, U.S.B.&M. S89°56'E - 77.25 (G.L.O.) N89°00'07"E - 2640.97' (Meas.) N89°00'07"E - 2459.40' (Meas.) Cap Marked Proportioned Peatross 5/8" rebar Not Set 738-2718 in Road (Meas.) LOT 1 55, (G.L.O.) SOO'50'18"E WELL LOCATION: 12-18-4-1W 1 OT 2 ELEV. UNGRADED GROUND = 5182.4' Spike Proportioned Not Set SOUTH LOT 3 (Meas.) 571 ,66 2638. WINDOW LOT 4 Spike Spike in Road N89°09'02"E - 2639.58' (Meas.) N89'08'13"E - 2462.32' (Meas.) S89°58'E - 77.23 (G.L.O.) SECTION CORNERS LOCATED 12-18-4-1W BASIS OF ELEV; Elevations are based on (Surface Location) NAD 83 an N.G.S. OPUS Correction. LOCATION: $LATITUDE = 40^{\circ} 07' 59.57"$ LAT. 40°04'09.56" LONG. 110°00'43.28" LONGITUDE = 110' 02' 45.52" (Tristate Aluminum Cap) Elev. 5281.57'

NEWFIELD EXPLORATION COMPANY

WELL LOCATION, 12-18-4-1W, LOCATED AS SHOWN IN THE NW 1/4 SW 1/4 (LOT 3) OF SECTION 18, T4S, R1W, U.S.B.&M. DUCHESNE COUNTY, UTAH.

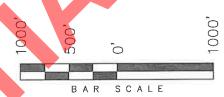

NOTES:

- 1. Well footages are measured at right angles to the Section Lines.
- 2. Bearings are based on Global Positioning Satellite observations.

THIS IS TO CERTIFY THAT OFFE ABOVE PEOF WAS PREPARED FROM FIELD OF THE ABOVE PEOF WAS PREPARED FROM FIELD OF ACTUME SURVEYS MADE BY ME OR UNDER WY SUPPRESSION AND THAT THE SAME ARE TRUE AND CORRECT TO THE BEST OF MY KNOWLEDGE WAS BOUNG 189377

REGISTERED LANG SU RASISTRA DON NO. DO STATE OF STATE

TRI STATE LAND SURVEYING & CONSULTING

180 NORTH VERNAL AVE. - VERNAL, UTAH 84078 (435) 781-2501

	(100) / 0101	
DATE SURVEYED: 06-28-11	SURVEYED BY: S.V.	VERSION:
DATE DRAWN: 06-30-11	DRAWN BY: F.T.M.	\/1
REVISED:	SCALE: 1" = 1000'	V 1


API Well Number: 43013509030000 Access Road Map North Myt Flattop 1. (0) Windy MYTON ₹0.6 mi. Bent 2.5 mi. 010 Myron DUCHESNE TOWNTAH C ± 0.6 mi. VALLE outh See Topo "B" PLEASANT Const Proposed Location 12-18-4-1W Valley sasant Britiphy 1703 DYNAM 15.4 Legend Existing Road Proposed Road **NEWFIELD EXPLORATION COMPANY** P: (435) 781-2501 F: (435) 781-2518 N Γri State 12-18-4-1W SEC. 18, T4S, R1W, U.S.B.&M. Land Surveying, Inc.

180 NORTH VERNAL AVE. VERNAL, UTAH 84078 **Duchesne County, UT.** C.H.M. REVISED: DRAWN BY: VERSION SHEET TOPOGRAPHIC MAP 06-30-2011 DATE: V1 1:100,000 SCALE:

API Well Number: 43013509030000 Access Road Map Myton ± 6.2 mi. BM Valley Pleasant HARVEY MAURICE ERWIN 518 HARVE ± 0.6 mi. HARVEY CARROLL/MAURICE T Ν BATTY 5236 WAYNE Nells ± 488 **Proposed Location** 12-18-4-1W Legend Existing Road Proposed Road FLEASA. **NEWFIELD EXPLORATION COMPANY** P: (435) 781-2501 F: (435) 781-2518 12-18-4-1W Land Surveying, Inc.

180 NORTH VERNAL AVE. VERNAL, UTAH 84078 SEC. 18, T4S, R1W, U.S.B.&M. **Duchesne County, UT.** DRAWN BY: C.H.M. REVISED: VERSION SHEET DATE: 06-30-2011 TOPOGRAPHIC MAP V1 В SCALE: 1 " = 2,000

API Well Number: 43013509030000 **Proposed Pipeline Map** Flume, BM HARVEY Tie in at Proposed MAURICE pleasant Waterline ERWIN ± 606 HARVEY Tie in at Proposed ± 1,325" Gas Pipeline HARVEY CARROLL/MAURICE ± 3,453 S 1,377 ANAL ± 1,373 Wells BATTY **Proposed Location** 12-18-4-1W Legend Existing Road Proposed Waterline Proposed Gas Pipeline **NEWFIELD EXPLORATION COMPANY** P: (435) 781-2501 F: (435) 781-2518 Ν 12-18-4-1W Land Surveying, Inc. SEC. 18, T4S, R1W, U.S.B.&M. 180 NORTH VERNAL AVE. VERNAL, UTAH 84078 **Duchesne County, UT.** DRAWN BY: C.H.M. REVISED: VERSION: SHEET 06-30-2011 DATE: TOPOGRAPHIC MAP C SCALE 1 " = 2,000 '

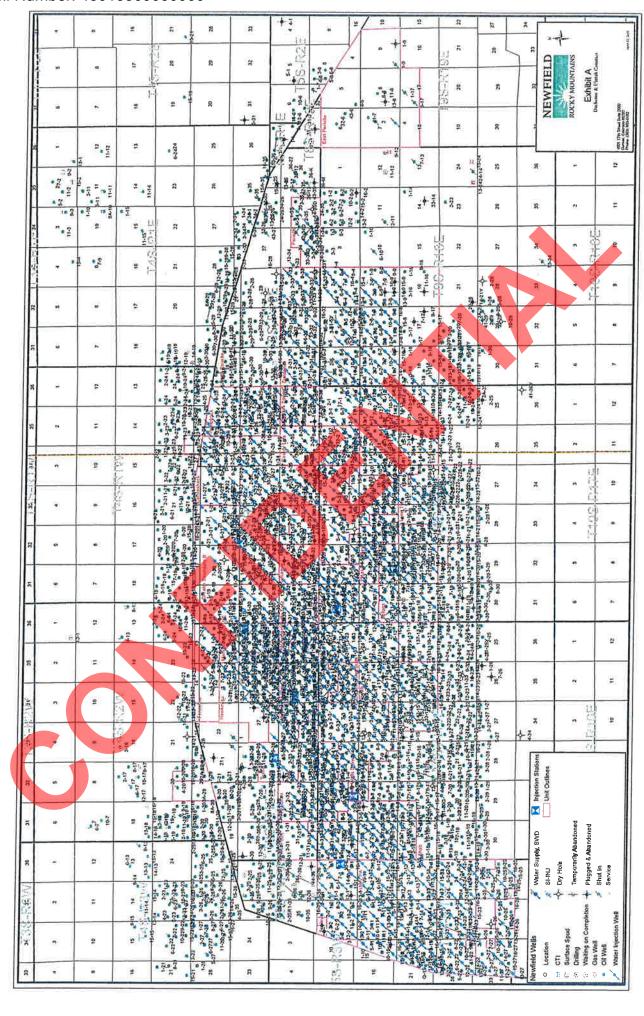

API Well Number: 43013509030000 Exhibit "B" Map **Proposed Location** 12-18-4-1W plea 5166 S GANAL Wells Legend TREATY 1 Mile Radius Proposed Location **NEWFIELD EXPLORATION COMPANY** P: (435) 781-2501 F: (435) 781-2518 Ν 12-18-4-1W Land Surveying, Inc.

180 NORTH VERNAL AVE. VERNAL, UTAH 84078 SEC. 18, T4S, R1W, U.S.B.&M. **Duchesne County, UT.** C.H.M. REVISED: DRAWN BY: VERSION: SHEET DATE: 06-30-2011 TOPOGRAPHIC MAP SCALE: 1 " = 2,000 '

AFFIDAVIT OF EASEMENT, RIGHT-OF-WAY AND SURFACE USE AGREEMENT

Roxann Eveland personally appeared before me, being duly sworn, deposes and with respect to State of Utah R649-3-34.7 says:

- My name is Roxann Eveland. I am a Landman for Newfield Production Company, whose address is 1001 17th Street, Suite 2000, Denver, CO 80202 ("Newfield").
- 2. Newfield is the Operator of the proposed Condor Trust 12-18-4-1 well to be located in Lot 3 (NWSW) of Section 18, Township 4 South, Range 1 West, Duchesne County, Utah (the "Drillsite Location"). The surface owner of the Drillsite Location is David R. Batty, whose address is 815 South 1500 West, Vernal, UT 84078 ("Surface Owner").
- 3. Newfield and the Surface Owner have agreed upon an Easement, Right-of-Way and Surface Use Agreement dated July 25, 2011 covering the Drillsite Location and access to the Drillsite Location.

FURTHER AFFIANT SAYETH NOT.

Poparn Eveland

ACKNOWLEDGEMENT

STATE OF COLORADO

§

COUNTY OF DENVER

<u>-8</u>-

Before me, a Notary Public, in and for the State, on this 25th day of July, 2011, personally appeared Roxann Eveland, to me known to be the identical person who executed the foregoing instrument, and acknowledged to me that she executed the same as her own free and voluntary act and deed for the uses and purposes therein set forth.

NOTARY PUBLIC

My Commission Expires:

EXHIBIT D

Township 4 South, Range 1West, Uintah Special Base and Meridian

Section 18: W/2SW/4 Lots 3 & 4 Except: Beginning at the Southwest corner of said Section 18; thence N 0°00'00" E 626.00 feet along west line of said Section; thence North 89°10'39" E 696.44 feet along existing fence and extension thereof to a fence corner; thence North 73°24'49" E 465.45 feet along an existing fence to the East line of Lot 4 (SW4SW4) of said Section; thence South 770.42 feet along said East line to the Southeast corner of said Lot 4; thence N 89°55'19" West 1,142.45 feet along South Line of said Section to the point of beginning.

Duchesne County, Utah being 51.64 acres, more or less

ARCHAEOLOGICAL, PALEONTOLOGICAL & BIOLOGICAL REPORT WAIVER

For the above referenced locations; **David R. Batty**, whose address is **815 South 1500 West, Vernal, UT 84078**, the Private Surface Owner. (Having an Easement, Right-Of-Way, and Surface Use Agreement with Newfield Production Company)

David R. Batty, representing this entity does agree to waive the request from the State of Utah and Bureau of Land Management for an Archaeological/Cultural, Paleontological, and Biological Resource Survey for any wells covered by the Surface Use Agreements dated 7/25/2011, between the above said private land owner and Newfield Production. This waiver hereby releases Newfield Production Company from this request.

David R. Batty Date 1/25/1

Private Surface Owner

Shon McKinnon

Date 07/25/2011

Newfield Production Company

NEWFIELD PRODUCTION COMPANY CONDOR TRUST 12-18-4-1W NW/SW SECTION 18, T4S, R1W DUCHESNE COUNTY, UTAH

THIRTEEN POINT SURFACE PROGRAM

1. **EXISTING ROADS**

See attached Topographic Map "A"

To reach Newfield Production Company well location site Condor Trust 12-18-4-1W located in the NW¹/₄ SW¹/₄ Section 18, T4S, R1W, S.L.B. & M., Duchesne County, Utah:

Proceed southwesterly out of Myton, Utah along Highway 40 - 1.4 miles \pm to the junction of this highway and UT State Hwy 53; proceed southerly -2.3 miles \pm to it's junction with an existing road to the east; proceed easterly and then southerly -4.2 miles \pm to it's junction with an existing road to the northeast; proceed in a northeasterly direction $-488 \pm$ to the proposed well location.

The highways mentioned in the foregoing paragraph are bituminous surfaced roads to the point where Highway 216 exists to the South, thereafter the roads are constructed with existing materials and gravel. The highways are maintained by Utah State road crews. All other roads are maintained by County crews.

The aforementioned dirt oil field service roads and other roads in the vicinity are constructed out of existing native materials that are prevalent to the existing area they are located in and range from clays to a sandy-clay shale material.

The roads for access during the drilling, completion and production phase will be maintained at the standards required by the State of Utah, or other controlling agencies. This maintenance will consist of some minor grader work for smoothing road surfaces and for snow removal.

2. PLANNED ACCESS ROAD

Approximately 488' of access road is proposed. See attached **Topographic Map "B"**.

The proposed access road will be an 18' crown road (9' either side of the centerline) with drainage ditches along either side of the proposed road whether it is deemed necessary in order to handle any run-off from normal meteorological conditions that are prevalent to this area. The maximum grade will be less than 8%.

There will be no culverts required along this access road. There will be barrow ditches and turnouts as needed along this road.

There are no fences encountered along this proposed road. There will be no new gates or cattle guards required.

All construction material for this access road will be borrowed material accumulated during construction of the access road.

3. **LOCATION OF EXISTING WELLS**

Refer to **EXHIBIT B**.

4. LOCATION OF EXISTING AND/OR PROPOSED FACILITIES

There are no existing facilities that will be used by this well.

It is anticipated that this well will be a producing oil well.

Upon construction of a tank battery, the well pad will be surrounded by a dike of sufficient capacity to contain at minimum 110% of the largest tank volume within the facility battery.

Tank batteries will be built to State specifications.

All permanent (on site for six (6) months or longer) structures, constructed or installed (including pumping units), will be painted a flat, non-reflective, earth tone color to match one of the standard environmental colors, as determined by the Rocky Mountain Five State Interagency Committee. All facilities will be painted within six months of installation.

5. LOCATION AND TYPE OF WATER SUPPLY

Newfield Production will transport water by truck for drilling purposes from the following water sources:

Johnson Water District Water Right: 43-10136

Maurice Harvey Pond Water Right: 47-1358

Neil Moon Pond Water Right: 43-11787

Newfield Collector Well

Water Right: 47-1817 (A30414DVA, contracted with the Uintah County Conservancy District).

There will be no water well drilled at this site

6. SOURCE OF CONSTRUCTION MATERIALS

All construction material for this location shall be borrowed material accumulated during construction of the location site and access road.

A mineral material application is not required for this location.

7. METHODS FOR HANDLING WASTE DISPOSAL

A small reserve pit (90' x 40' x 8' deep, or less) will be constructed from native soil and clay materials. The reserve pit will receive the processed drill cutting (wet sand, shale & rock) removed from the wellbore. Any drilling fluids, which do accumulate in the pit as a result of shale-shaker carryover, cleaning of the sand trap, etc., will be promptly reclaimed. All drilling fluids will be fresh water based, typically containing Total Dissolved Solids of less than 3000 PPM. No potassium chloride, chromates, trash, debris, nor any other substance deemed hazardous will be placed in this pit. A 16 mil liner with felt will be required. Newfield requests approval that a flare pit be constructed and utilized on this location.

A portable toilet will be provided for human waste.

A trash basket will be provided for garbage (trash) and hauled away to an approved disposal site at the completion of the drilling activities.

Immediately upon first production, all produced water will be confined to a steel storage tank. If the production water meets quality guidelines, it is transported to the Ashley, Monument Butte, Jonah, and Beluga water injection facilities by company or contract trucks. Subsequently, the produced water is injected into approved Class II wells to enhance Newfield's secondary recovery project.

Water not meeting quality criteria, is disposed at Newfield's Pariette #4 disposal well (Sec. 7, T9S R19E) or at State of Utah approved surface disposal facilities.

8. **ANCILLARY FACILITIES:**

There are no ancillary facilities planned for at the present time and none foreseen in the near future.

9. **WELL SITE LAYOUT:**

See attached Location Layout Sheet.

Fencing Requirements

All pits will be fenced according to the following minimum standards:

- a) A 39-inch net wire shall be used with at least one strand of barbed wire on top of the net.
- b) The net wire shall be no more than two (2) inches above the ground. The barbed wire shall be three (3) inches above the net wire. Total height of the fence shall be at least forty-two (42) inches.
- c) Corner posts shall be centered and/or braced in such a manner to keep tight at all times
- d) Standard steel, wood or pipe posts shall be used between the corner braces. Maximum distance between any two posts shall be no greater than sixteen (16) feet.
- e) All wire shall be stretched, by using a stretching device, before it is attached to the corner posts.

The reserve pit fencing will be on three (3) sides during drilling operations and on the fourth side when the rig moves off location. Pits will be fenced and maintained until cleanup.

10. PLANS FOR RESTORATION OF SURFACE:

a) Producing Location

Immediately upon well completion, the location and surrounding area will be cleared of all unused tubing, equipment, debris, material, trash and junk not required for production.

The reserve pit and that portion of the location not needed for production facilities/operations will be recontoured to the approximated natural contours. Weather permitting, the reserve pit will be reclaimed within one hundred twenty (120) days from

the date of well completion. Before any dirt work takes place, the reserve pit must have all fluids and hydrocarbons removed.

b) **Dry Hole Abandoned Location**

At such time as the well is plugged and abandoned, the operator shall submit a subsequent report of abandonment and the State of Utah will attach the appropriate surface rehabilitation conditions of approval.

11. **SURFACE OWNERSHIP: David R. Batty**.

See attached Affidavit of Easement, Right of Way, and Surface Use Agreement.

12. **OTHER ADDITIONAL INFORMATION:**

Newfield Production Company requests 488' of planned access road to be granted. **Refer to Topographic Map "B".** Newfield Production Company requests 4,966' of surface gas line to be granted. Newfield Production Company requests 6,761' of buried water line to be granted.

It is proposed that the disturbed area will be 60' wide to allow for construction of the proposed access road, a 10" or smaller gas gathering line, a 3" poly fuel gas line, a buried 3" steel water injection line and a buried 3" poly water return line. The planned access road will consist of a 18' permanent running surface (9' either side of the centerline) crowned and ditched in order to handle any run-off from any precipitation events that are prevalent to this area. The maximum grade will be less than 8%. There will be no culverts required along this access road. There will be turnouts as needed along this road to allow for increases in potential traffic issues. There are no fences encountered along this proposed road. There will be no new gates or cattle guards required. All construction material for this access road will be borrowed material accumulated during construction of the access road.

Both the proposed surface gas and buried water lines will tie in to the existing pipeline infrastructure. **Refer to Topographic Map "C."** The proposed water pipelines will be buried in a 4-5' deep trench constructed with a trencher or backhoe for the length of the proposal. The equipment will run on the surface and not be flat bladed to minimize surface impacts to precious topsoil in these High Desert environments. If possible, all proposed surface gas pipelines will be installed on the same side of the road as existing gas lines. The construction phase of the planned access road, proposed gas lines and proposed water lines will last approximately (5) days.

In the event that the proposed well is converted to a water injection well, a Sundry Notice form will be applied for through the State of Utah DOGM.

- a) Newfield Production Company is responsible for informing all persons in the area who are associated with this project that they will be subject to prosecution for knowingly disturbing historic or archaeological sites, or for collecting artifacts. If historic or archaeological materials are uncovered during construction, Newfield is to immediately stop work that might further disturb such materials and contact the Authorized Officer.
- b) Newfield Production will control noxious weeds along rights-of-way for roads, pipelines, well sites or other applicable facilities. On State administered land it is required that a Pesticide Use Proposal shall be submitted and given approval prior to the application of herbicides or other possible hazardous chemicals.
- c) Drilling rigs and/or equipment used during drilling operations on this well site will not be stacked or stored on State Lands after the conclusion of drilling operations or at any other time without State authorization. However, if State authorization is obtained, it is only a

temporary measure to allow time to make arrangements for permanent storage on commercial facilities.

Additional Surface Stipulations

All lease and/or unit operations will be conducted in such a manner that full compliance is made with all applicable laws and regulations, Onshore Oil and Gas Orders, the approved plan of operations and any applicable Notice to Lessees. A copy of these conditions will be furnished to the field representative to ensure compliance.

Hazardous Material Declaration

Newfield Production Company guarantees that during the drilling and completion of the Condor Trust 12-18-4-1W, Newfield will not use, produce, store, transport or dispose 10,000# annually of any of the hazardous chemicals contained in the Environmental Protection Agency's consolidated list of chemicals subject to reporting under Title III Superfund Amendments and Reauthorization Act (SARA) of 1986. Newfield also guarantees that during the drilling and completion of the Condor Trust 12-18-4-1W Newfield will use, produce, store, transport or dispose less than the threshold planning quantity (T.P.Q.) of any extremely hazardous substances as defined in 40 CFR 355.

A complete copy of the approved APD, if applicable, shall be on location during the construction of the location and drilling activities.

Newfield Production Company or a contractor employed by Newfield Production shall contact the State office at (801) 722-3417, 48 hours prior to construction activities.

The State office shall be notified upon site completion prior to moving on the drilling rig.

13. <u>LESSEE'S OR OPERATOR'S REPRENSENTATIVE AND CERTIFICATION:</u>

Representative

Name: Tim Eaton

Address: Newfield Production Company

Route 3, Box 3630 Myton, UT 84052

Telephone: (435) 646-3721

Certification

Please be advised that Newfield Production Company is considered to be the operator of well #12-18-4-1W, NW/SW Section 18, T4S, R1W, Duchesne County, Utah and is responsible under the terms and conditions of the lease for the operations conducted upon the leased lands. Bond coverage is provided by Bond #B001834.

Lhereby certify that the proposed drill site and access route have been inspected, and I am familiar with the conditions which currently exist; that the statements made in this plan are true and correct to the best of my knowledge; and that the work associated with the operations proposed here will be performed by Newfield Production Company and its contractors and subcontractors in conformity with this plan and the terms and conditions under which it is approved. This statement is subject to the provisions of the 18 U.S.C. 1001 for the filing of a false statement.

7/28/11	
Date	Mandie Crozier
	Regulatory Analyst
	Newfield Production Company

2-M SYSTEM

Blowout Prevention Equipment Systems



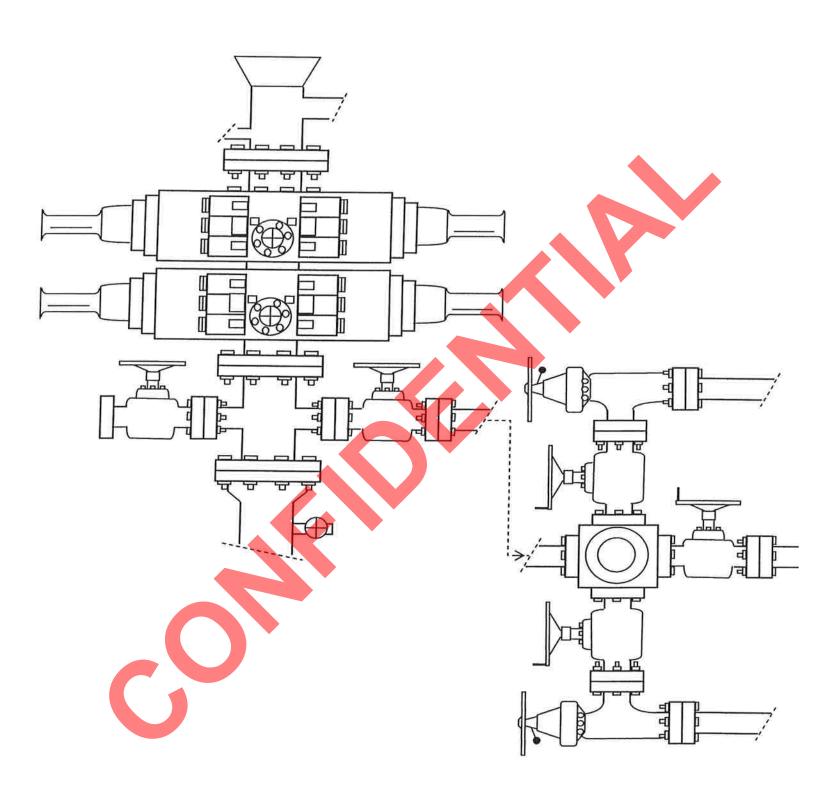


EXHIBIT C

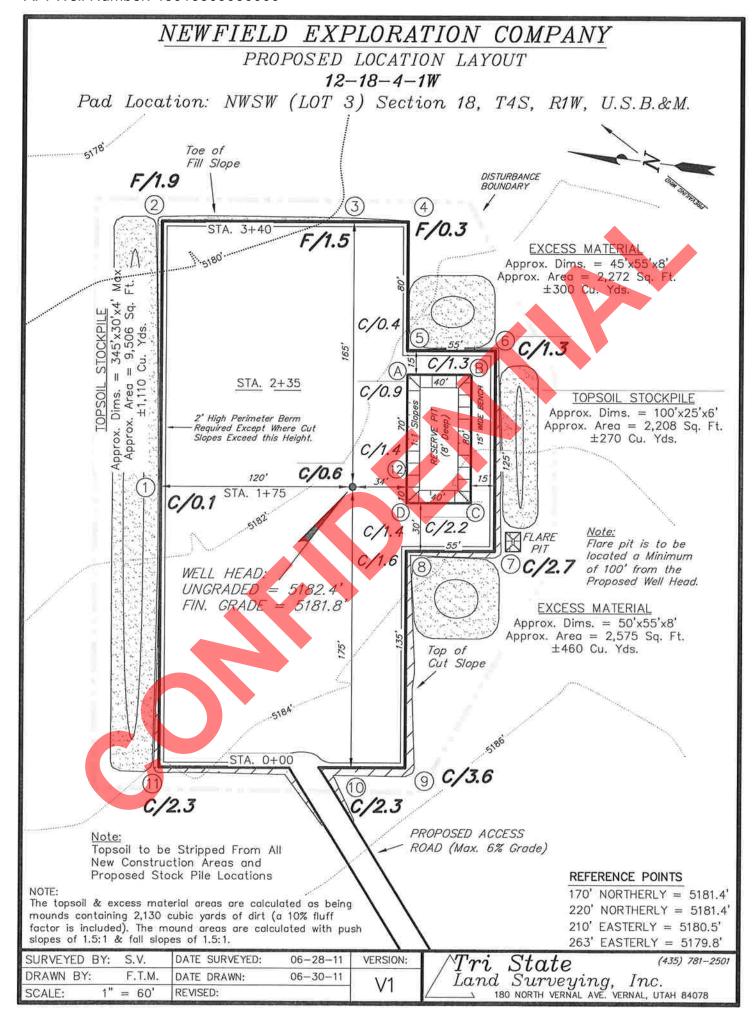

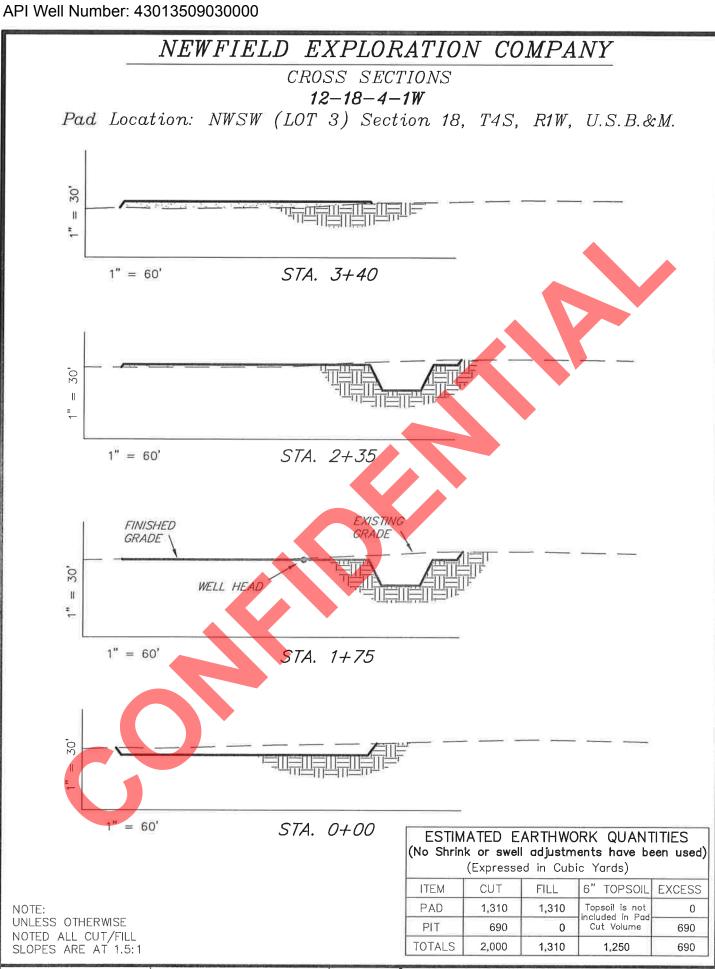

SURVEYED BY: S.V.	DATE SURVEYED:	06-28-11	VERSION:	$\land Tri \ State$ (435) 781-2501
DRAWN BY: F.T.M.	DATE DRAWN:	06-30-11	\/1	/ Land Surveying, Inc.
SCALE: $1'' = 60'$	REVISED:		V I	180 NORTH VERNAL AVE. VERNAL, UTAH 84078

NEWFIELD EXPLORATION COMPANY TYPICAL RIG LAYOUT 12-18-4-1W Pad Location: NWSW (LOT 3) Section 18, T4S, R1W, U.S.B.&M. STORAGE TANK YELLOW DOG BOILER FUEL TOILET

40'

DATA

55'

PROPOSED ACCESS ROAD (Max. 6% Grade)

GHT PLANT

WATER


SURVEYED BY: S.V. DATE SURVEYED: 06-28-11 VERSION: DRAWN BY: F.T.M. DATE DRAWN: 06-30-11 SCALE: 1" = 60'REVISED:

TRAILERS

Tri~State (435) 781-1. Land Surveying, Inc. $__$ 180 NORTH VERNAL AVE. VERNAL, UTAH 84078 (435) 781-2501

FLARE PIT

<u>Note:</u> Flare pit is to be located a Minimum of 100' from the Proposed Well Head.

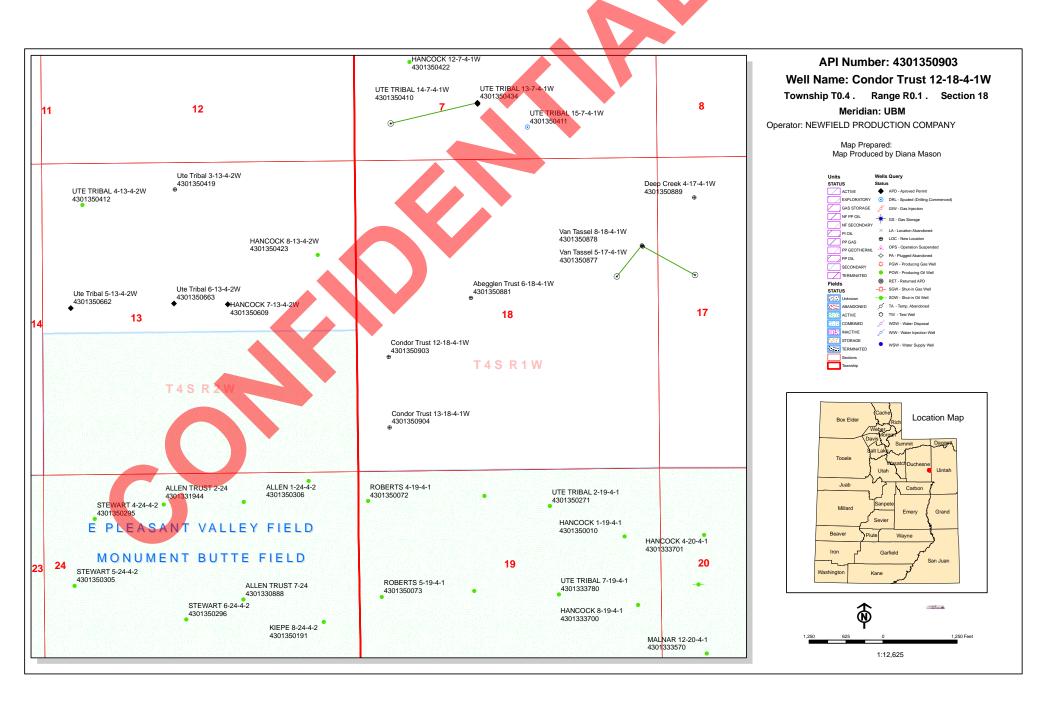


BOPE REVIEW NEWFIELD PRODUCTION COMPANY Condor Trust 12-18-4-1W 43013509030000

XV II XI					_			
Well Name		NEWFIELD	PR	ODUCTION (COI	MPANY Cond	or 1	Trust 12-18-4-1
String		Surf	Ц	Prod	Ц			
Casing Size(")		8.625		5.500]		
Setting Depth (TVD)		500		7380				
Previous Shoe Setting Dep	th (TVD)	0		500				
Max Mud Weight (ppg)	Max Mud Weight (ppg)				i			
BOPE Proposed (psi)		500		2000	ĺ			
Casing Internal Yield (psi)		2950		4810	i			
Operators Max Anticipate	d Pressure (psi)	3173		8.3	İ			
Calculations	Sur	f String	String 8.625			8.6	25	5 "
Max BHP (psi)		.052*Sett	ting	g Depth*M	W	216		
								BOPE Adequate For Drilling And Setting Casing at Depth?
MASP (Gas) (psi)	Max	k BHP-(0.12	*S	etting Dep	th)	156		YES air drill
MASP (Gas/Mud) (psi)	Max	x BHP-(0.22	*S	etting Dep	th)	106		YES OK
								*Can Full Expected Pressure Be Held At Previous Shoe?
Pressure At Previous Shoe	Max BHP22*(Setting D	epth - Previo	ous	Shoe Dep	th)	106		NØ OK
Required Casing/BOPE To	est Pressure=					500	<u> </u>	psi
*Max Pressure Allowed @	Previous Casing Shoe=					0		psi *Assumes 1psi/ft frac gradient
							7	
Calculations	Proc	l String				5.5	00	0 "
Max BHP (psi)		.052*Sett	ting	g Depth*M	W	3224		
							_	BOPE Adequate For Drilling And Setting Casing at Depth?
MASP (Gas) (psi)	Max	k BHP-(0.12	*S	etting Dep	th)	2338	Z	NO .
MASP (Gas/Mud) (psi)	Max	x BHP-(0.22	*S	etting Dep	th)	1600		YES OK
								*Can Full Expected Pressure Be Held At Previous Shoe?
Pressure At Previous Shoe	Max BHP22*(Setting D	epth - Previo	ous	Shoe Dep	th)	1710		NO Reasonable for area
Required Casing/BOPE To	est Pressure=					2000		j psi
*Max Pressure Allowed @	Previous Casing Shoe=					500		psi *Assumes 1psi/ft frac gradient
Calculations	S	tring						"
Max BHP (psi)		.052*Sett	ting	g Depth*M	W	=		
						<u> </u>	_	BOPE Adequate For Drilling And Setting Casing at Depth?
MASP (Gas) (psi)	Max	k BHP-(0.12	*S	etting Dep	th)	-	_	NO I
MASP (Gas/Mud) (psi)	Max	x BHP-(0.22	*S	etting Dep	th)		=	NO
						1		*Can Full Expected Pressure Be Held At Previous Shoe?
Pressure At Previous Shoe	Max BHP22*(Setting D	epth - Previo	ous	Shoe Dep	th)	-	_	NO I
Required Casing/BOPE To	est Pressure=						=	psi
*Max Pressure Allowed @	Previous Casing Shoe=							psi *Assumes 1psi/ft frac gradient
Calculations	S	tring						lu l
Max BHP (psi)			ting	g Depth*M	W		<u> </u>	
- /				-		1	_	BOPE Adequate For Drilling And Setting Casing at Depth?
MASP (Gas) (psi)	Max	x BHP-(0.12	*S	etting Dep	th)		_	NO I
MASP (Gas/Mud) (psi)		x BHP-(0.22			_		=	NO I
(Suotizua) (Por)	17102	(0.22		g 20p		<u> </u>	_	*Can Full Expected Pressure Be Held At Previous Shoe?
Pressure At Previous Shoe	Max BHP- 22*(Setting D	epth - Previo	2110	Shoe Den	th):	=	_	
Required Casing/BOPE To		-r 1101R				<u> </u>	=	NO
ACQUITED CASHIS/DOFE TO	ot 1 i cosule—						\Box	psi

*Max Pressure Allowed @ Previous Casing Shoe= psi *Assumes 1psi/ft frac gradient



43013509030000 Condor Trust 12-18-4-1W

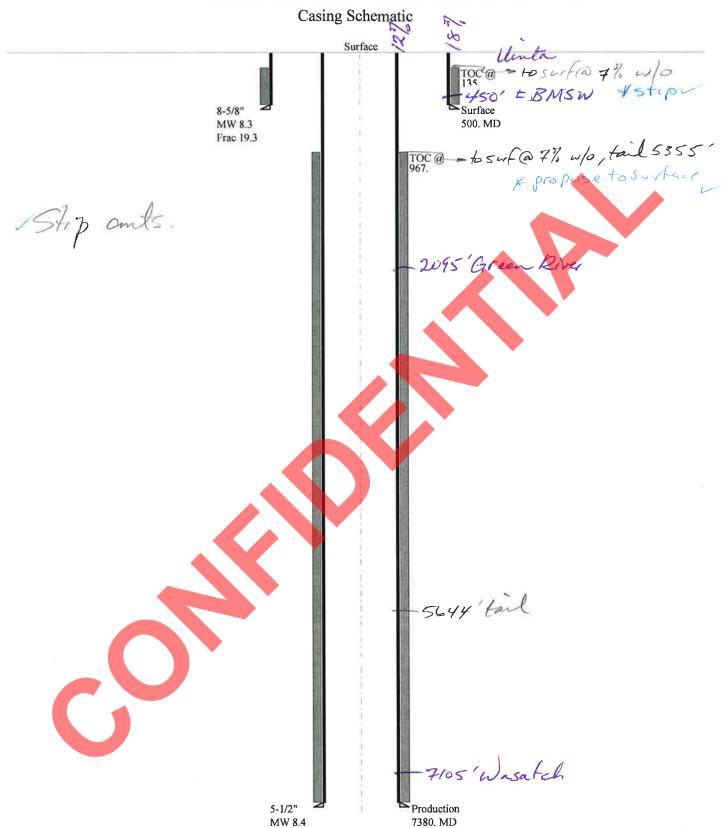

Well name:

43013509030000 Condor Trust 12-18-4-1W

Operator:

NEWFIELD PRODUCTION COMPANY

String type:

Surface

Project ID:

Location:

DUCHESNE COUNTY 43-013-50903

Environment:

Design	pa	ra	m	ete	rs	:
Collapse	2					

Mud weight: Design is based on evacuated pipe.

8.330 ppg

Minimum design factors: Collapse:

Design factor

1.125

H2S considered?

No Surface temperature: 74 °F Bottom hole temperature: 81 °F 1.40 °F/100ft Temperature gradient:

Minimum section length: 100 ft

Burst:

Design factor

1.00

1.80 (J)

1.70 (J)

1.60 (J)

1.50 (J)

1.50 (B)

5.90

Cement top:

135 ft

Burst

Max anticipated surface pressure:

Internal gradient: Calculated BHP

No backup mud specified.

440 psi 0.120 psi/ft

500 psi

Tension: 8 Round STC:

8 Round LTC: Buttress: Premium:

Body yield:

500

Tension is based on air weight. Neutral point: 437 ft Non-directional string.

Re subsequent strings:

Injection pressure:

12

Next setting depth: 7,380 ft Next mud weight: Next setting BHP: Fracture mud wt: Fracture depth:

8.400 ppg 3,220 psi 19.250 ppg 500 ft 500 psi

20.34 J

Run Segment Nominal True Vert Measured Drift Est. End Depth Cost Length Size Weight Grade Finish Depth Diameter Seq (ft) (in) (lbs/ft) (ft) (ft) (in) (\$) 500 7.972 2573 500 8.625 24.00 J-55 ST&C 500 1 Run Collapse Collapse Collapse Burst Burst **Burst** Tension **Tension** Tension Strength Design Load Strength Design Load Strength Design Seq Load Factor (psi) **Factor** (kips) (kips) **Factor** (psi) (psi) (psi)

2950

Helen Sadik-Macdonald Prepared Div of Oil, Gas & Mining

1370

6.333

Phone: 801 538-5357 FAX: 801-359-3940

Date: August 2,2011 Salt Lake City, Utah

244

Remarks:

1

216

Collapse is based on a vertical depth of 500 ft, a mud weight of 8.33 ppg. The casing is considered to be evacuated for collapse purposes. Collapse strength is based on the Westcott, Dunlop & Kemler method of biaxial correction for tension.

Burst strength is not adjusted for tension.

Well name:

43013509030000 Condor Trust 12-18-4-1W

Minimum design factors:

Operator:

NEWFIELD PRODUCTION COMPANY

String type:

Production

Project ID: 43-013-50903

Location:

DUCHESNE COUNTY

Environment:

Collapse

Mud weight:

Design parameters:

8.400 ppg Design is based on evacuated pipe.

Collapse: Design factor

1.125

H2S considered? Surface temperature: No 74 °F

Bottom hole temperature:

177 °F 1.40 °F/100ft

Temperature gradient: Minimum section length:

100 ft

Burst:

Design factor

1.00

Cement top:

967 ft

Burst

Max anticipated surface

No backup mud specified.

pressure:

1,597 psi 0.220 psi/ft

Internal gradient: Calculated BHP

3,220 psi

Tension:

8 Round STC:

8 Round LTC:

Buttress: Premium:

Body yield:

1.60 (J) 1.50 (J)

1.80 (J) 1.80 (J)

1.60 (B)

Tension is based on air weight. Neutral point: 6,442 ft Non-directional string.

Run	Segment		Nominal		End	True Vert	Measured	Drift	Est.	
Seq	Length	Size	Weight	Grade	Finish	Depth	Depth	Diameter	Cost	
	(ft)	(in)	(lbs/ft)			(ft)	(ft)	(in)	(\$)	
1	7380	5.5	15.50	J-55	LT&C	7380	7380	4.825	26059	
Run	Collapse	Collapse	Collapse	Burst	Burst	Burst	Tension	Tension	Tension	
Seq	Load	Strength	Design	Load	Strength	Design	Load	Strength	Design	
	(psi)	(psi)	Factor	(psi)	(psi)	Factor	(kips)	(kips)	Factor	
1	3220	4040	1.255	3220	4810	1.49	114.4	217	1.90 J	
		_								

Prepared by:

Helen Sadik-Macdonald Div of Oil, Gas & Mining

Phone: 801 538-5357 FAX: 801-359-3940

Date: August 2,2011 Salt Lake City, Utah

Remarks:

Collapse is based on a vertical depth of 7380 ft, a mud weight of 8.4 ppg. The casing is considered to be evacuated for collapse purposes. Collapse strength is based on the Westcott, Dunlop & Kemler method of biaxial correction for tension.

Burst strength is not adjusted for tension.

ON-SITE PREDRILL EVALUATION

Utah Division of Oil, Gas and Mining

Operator NEWFIELD PRODUCTION COMPANY

Well Name Condor Trust 12-18-4-1W

API Number 43013509030000 APD No 4269 Field/Unit UNDESIGNATED

Location: 1/4,1/4 NWSW Sec 18 Tw 4.0S Rng 1.0W 1980 FSL 571 FWL

GPS Coord (UTM) Surface Owner David R. Batty

Participants

M. Jones (UDOGM), T. Eaton (Newfield). The landowner was invited but chose not to attend the pre-site meeting.

Regional/Local Setting & Topography

This location is staked approximately 8 road miles south of Myton, Utah. The property is on both sides of Wells Draw, however the staking is on the north side of the Draw. The topography is pretty flat. Slightly sloped to the east. The landowner was invited but chose not to attend the pre-site meeting.

Surface Use Plan

Current Surface Use

Grazing

Wildlfe Habitat

New Road Miles Well Pad Src Const Material Surface Formation

0.1 Width 154 Length 340 Offsite

Ancillary Facilities

Waste Management Plan Adequate?

Environmental Parameters

Affected Floodplains and/or Wetlands N

Flora / Fauna

greasewood and ragweed.

Soil Type and Characteristics

clay.

Erosion Issues N

Sedimentation Issues N

Site Stability Issues Y

A pit run base will be needed.

Drainage Diverson Required? Y

Divert drainages around and away from roadway and drill pad.

Berm Required? Y

Berm location to prevent fluids from entering and/or leaving the pad.

9/19/2011 Page 1

Erosion Sedimentation Control Required? N

Paleo Survey Run? N Paleo Potental Observed? N Cultural Survey Run? N Cultural Resources? N

Reserve Pit

Site-Specific Factors	Site Ra		
Distance to Groundwater (feet)	25 to 75	15	
Distance to Surface Water (feet)	300 to 1000	2	
Dist. Nearest Municipal Well (ft)	>5280	0	
Distance to Other Wells (feet)	>1320	0	
Native Soil Type	Mod permeability	10	
Fluid Type	Fresh Water	5	
Drill Cuttings	Normal Rock	0	
Annual Precipitation (inches)	10 to 20	5	
Affected Populations			
Presence Nearby Utility Conduits	Not Present	0	
	Final Score	37	1 Sensitivity Level

Characteristics / Requirements

Dugout earthen (80' x 40' x 8') excluded from pad dimensions.

Closed Loop Mud Required? N Liner Required? Y Liner Thickness 16 Pit Underlayment Required? N

Other Observations / Comments

Evaluator	$\overline{}$		Date / Time
Mark Jones			8/10/2011

9/19/2011 Page 2

Application for Permit to Drill Statement of Basis

9/19/2011 Utah Division of Oil, Gas and Mining

Page 1

APD No	API WellNo	Status	Well Type	Surf Owner	CBM
4269	43013509030000	LOCKED	OW	P	No
Operator	NEWFIELD PRODUCTION	COMPANY	Surface Owner-APD	David R. Batt	у
Well Name	Condor Trust 12-18-4-1W		Unit		
Field	UNDESIGNATED		Type of Work	DRILL	

Location NWSW 18 4S 1W U 1980 FSL 571 FWL GPS Coord (UTM) 581337E 4442768N

Geologic Statement of Basis

Newfield proposes to set 500' of surface casing at this location. The depth to the base of the moderately saline water at this location is estimated to be at a depth of 450'. A search of Division of Water Rights records shows 7 water wells within a 10,000 foot radius of the center of Section 18. Depth is listed for only 1 well at 24 feet. Listed uses are irrigation, stock watering and domestic. The surface formation at this site is the Uinta Formation. The Uinta Formation is made up of interbedded shales and sandstones. The sandstones are mostly lenticular and discontinuous and should not be an interconnected, high volume source of useable ground water. The proposed surface casing should adequately protect useable ground water in this area.

Brad Hill
APD Evaluator

Brad Hill
Date / Time

Surface Statement of Basis

This location is staked approximately 8 road miles south of Myton, Utah. The property is on both sides of Wells Draw, however the staking is on the north side of the Draw. The topography is pretty flat. Slightly sloped to the east. The landowner was invited but chose not to attend the pre-site meeting. A traditional reserve pit is planned for this location, however high ground water is a potential. The use of a traditional pit will be determined by the depth and amount of ground water found while excavating the pit.

Mark Jones 8/10/2011
Onsite Evaluator Date / Time

Conditions of Approval / Application for Permit to Drill

Category Condition

Pits A synthetic liner with a minimum thickness of 16 mils shall be properly installed and maintained in the reserve pit.

Surface The well site shall be bermed to prevent fluids from leaving the pad.

Surface Drainages adjacent to the proposed pad shall be diverted around the location.

Surface The reserve pit shall be fenced upon completion of drilling operations.

WORKSHEET APPLICATION FOR PERMIT TO DRILL

APD RECEIVED: 7/28/2011 **API NO. ASSIGNED:** 43013509030000

WELL NAME: Condor Trust 12-18-4-1W

OPERATOR: NEWFIELD PRODUCTION COMPANY (N2695) **PHONE NUMBER:** 435 646-4825

CONTACT: Mandie Crozier

PROPOSED LOCATION: NWSW 18 040S 010W Permit Tech Review:

> **SURFACE: 1980 FSL 0571 FWL Engineering Review:**

> **Geology Review: BOTTOM:** 1980 FSL 0571 FWL

COUNTY: DUCHESNE LATITUDE: 40.13320 UTM SURF EASTINGS: 581337.00

FIELD NAME: UNDESIGNATED

LEASE TYPE: 4 - Fee

LEASE NUMBER: Fee PROPOSED PRODUCING FORMATION(S): GREEN RIVER

SURFACE OWNER: 4 - Fee COALBED METHANE: NO

LOCATION AND SITING: **RECEIVED AND/OR REVIEWED:** R649-2-3. PLAT Bond: STATE/FEE - B001834 Unit: **Potash** R649-3-2. General Oil Shale 190-5 **Oil Shale 190-3** R649-3-3. Exception Oil Shale 190-13 **Drilling Unit Board Cause No:** R649-3-2 Water Permit: 437478 **Effective Date:** RDCC Review: ✓ Fee Surface Agreement Siting: Intent to Commingle R649-3-11. Directional Drill **Commingling Approved**

Comments: Presite Completed

Stipulations:

5 - Statement of Basis - bhill 8 - Cement to Surface -- 2 strings - hmacdonald

23 - Spacing - dmason

LONGITUDE: -110.04530 NORTHINGS: 4442768.00 API Well No: 43013509030000



State of Utah

DEPARTMENT OF NATURAL RESOURCES

MICHAEL R. STYLER
Executive Director

Division of Oil, Gas and Mining

JOHN R. BAZA
Division Director

Permit To Drill

Well Name: Condor Trust 12-18-4-1W

API Well Number: 43013509030000

Lease Number: Fee

Surface Owner: FEE (PRIVATE)

Approval Date: 9/19/2011

Issued to:

NEWFIELD PRODUCTION COMPANY, Rt 3 Box 3630, Myton, UT 84052

Authority:

Pursuant to Utah Code Ann. §40-6-1 et seq., and Utah Administrative Code R649-3-1 et seq., the Utah Division of Oil, Gas and Mining issues conditions of approval, and permit to drill the listed well. This permit is issued in accordance with the requirements of R649-3-2. The expected producing formation or pool is the GREEN RIVER Formation(s), completion into any other zones will require filing a Sundry Notice (Form 9). Completion and commingling of more than one pool will require approval in accordance with R649-3-22.

Duration:

This approval shall expire one year from the above date unless substantial and continuous operation is underway, or a request for extension is made prior to the expiration date

General:

Compliance with the requirements of Utah Admin. R. 649-1 et seq., the Oil and Gas Conservation General Rules, and the applicable terms and provisions of the approved Application for permit to drill.

Conditions of Approval:

This proposed well is located in an area for which drilling units (well spacing patterns) have not been established through an order of the Board of Oil, Gas and Mining (the "Board"). In order to avoid the possibility of waste or injury to correlative rights, the operator is requested, once the well has been drilled, completed, and has produced, to analyze geological and engineering data generated therefrom, as well as any similar data from surrounding areas if available. As soon as is practicable after completion of its analysis, and if the analysis suggests an area larger than the quarter-quarter section upon which the well is located is being drained, the operator is requested to seek an appropriate order from the Board establishing drilling and spacing units in conformance with such analysis by filing a Request for Agency Action with the Board.

Cement volumes for the 8 5/8" and 5 1/2" casing strings shall be determined from actual hole diameters in order to place cement from the pipe setting depths back to the surface.

Compliance with the Conditions of Approval/Application for Permit to Drill outlined in the Statement of Basis (copy attached).

Additional Approvals:

The operator is required to obtain approval from the Division of Oil, Gas and mining before

API Well No: 43013509030000

performing any of the following actions during the drilling of this well:

- Any changes to the approved drilling plan contact Dustin Doucet
- Significant plug back of the well contact Dustin Doucet
- Plug and abandonment of the well contact Dustin Doucet

Notification Requirements:

The operator is required to notify the Division of Oil, Gas and Mining of the following actions during drilling of this well:

- Within 24 hours following the spudding of the well contact Carol Daniels OR
- submit an electronic sundry notice (pre-registration required) via the Utah Oil & Gas website at http://oilgas.ogm.utah.gov
- 24 hours prior to testing blowout prevention equipment contact Dan Jarvis
- 24 hours prior to cementing or testing casing contact Dan Jarvis
- Within 24 hours of making any emergency changes to the approved drilling program contact Dustin Doucet
- 24 hours prior to commencing operations to plug and abandon the well contact Dan Jarvis

Contact Information:

The following are Division of Oil, Gas and Mining contacts and their telephone numbers (please leave a voicemail message if the person is not available to take the call):

- Carol Daniels 801-538-5284 office
- Dustin Doucet 801-538-5281 office

801-733-0983 - after office hours

• Dan Jarvis 801-538-5338 - office

801-231-8956 - after office hours

Reporting Requirements:

All reports, forms and submittals as required by the Utah Oil and Gas Conservation General Rules will be promptly filed with the Division of Oil, Gas and Mining, including but not limited to:

- Entity Action Form (Form 6) due within 5 days of spudding the well
- Monthly Status Report (Form 9) due by 5th day of the following calendar month
- Requests to Change Plans (Form 9) due prior to implementation
- Written Notice of Emergency Changes (Form 9) due within 5 days
- Notice of Operations Suspension or Resumption (Form 9) due prior to implementation
- Report of Water Encountered (Form 7) due within 30 days after completion
- Well Completion Report (Form 8) due within 30 days after completion or plugging

Approved By:

For John Rogers Associate Director, Oil & Gas



BLM - Vernal Field Office - Notification Form

Operator Newfield Exploration Rig Name/# Ross 29 Submitted By Branden Arnold Phone Number 435-401-0223 Well Name/Number Condor Trust 12-18-4-1W Otr/Otr NW/SW Section 18 Township 4S Range 1W Lease Serial Number Fee API Number 43-013-50903 Spud Notice – Spud is the initial spudding of the well, not drilling out below a casing string. Date/Time 9/30/11 9:00 AM \bowtie PM \bowtie Casing – Please report time casing run starts, not cementing times. Surface Casing **Intermediate Casing Production Casing** Liner Other Date/Time <u>9/30/11</u> <u>4:00</u> AM ☐ PM ☒ **BOPE** Initial BOPE test at surface casing point BOPE test at intermediate casing point 30 day BOPE test Other Date/Time _____ AM PM Remarks _____

STATE OF UTAH

DEPARTMENT OF NATURAL RESOURCES
DIVISION OF OIL, GAS AND MINING

	FEE								
SUNDRY	6. IF INDIAN, ALLOTTEE OR TRIBE NAME:								
	ill new wells, significantly deepen existing wells tall tall all tall all tall all tall all			7. UNIT or CA AGREEMENT NAME:					
1. TYPE OF WELL: OIL WELL	GAS WELL OTHER			WELL NAME and NUMBER:					
	GAS WELL OTHER			CONDOR TRUST 12-18-4-1W					
2. NAME OF OPERATOR:				9. API NUMBER:					
NEWFIELD PRODUCTION COM 3. ADDRESS OF OPERATOR:	4301350903 10. FIELD AND POOL, OR WILDCAT:								
	3. ADDRESS OF OPERATOR: PHONE NUMBER Route 3 Box 3630 CITY Myton STATE UT ZIP 84052 435.646.3721								
4. LOCATION OF WELL:	erri Myton Sixib Ci	211 01032	133.040.3721	MYTON-TRIBAL EDA					
FOOTAGES AT SURFACE:				COUNTY: DUCHESNE					
OTR/OTR. SECTION, TOWNSHIP, RANGE,	MERIDIAN: NWSW, 18, T4S, R1W			STATE: UT					
	PRIATE BOXES TO INDICAT			ORT, OR OTHER DATA					
TYPE OF SUBMISSION		T	YPE OF ACTION						
☐ NOTICE OF INTENT	ACIDIZE	DEEPEN		REPERFORATE CURRENT FORMATION					
(Submit in Duplicate)	ALTER CASING	FRACTURE	TREAT	SIDETRACK TO REPAIR WELL					
Approximate date work will	CASING REPAIR	NEW CONS	TRUCTION	TEMPORARITLY ABANDON					
	CHANGE TO PREVIOUS PLANS	OPERATOR	CHANGE	TUBING REPAIR					
	CHANGE TUBING	PLUG AND	ABANDON	VENT OR FLAIR					
SUBSEQUENT REPORT	CHANGE WELL NAME	PLUG BAC	K	WATER DISPOSAL					
(Submit Original Form Only)	CHANGE WELL STATUS	PRODUCT	ON (START/STOP)	WATER SHUT-OFF					
Date of Work Completion:	COMMINGLE PRODUCING FORMATIONS	=	TION OF WELL SITE	X OTHER: - Spud Notice					
10/04/2011	CONVERT WELL TYPE	=	ETE - DIFFERENT FORMATION	A CHIZA SPACHOLOG					
44 0533000000000000000000000000000000000									
On 9/30/11 MIRU Ross #29	t with 250 sks of class "G" w/ 2% C	of 12 1/4" hole	with air mist. TIH W/	11 Jt's 8 5/8" J-55 24# csgn. Set @					
NAME (PLEASE PRINT) Branden Arnold	i		TITI E						
(1 55105 1 1111)	proje 1	***************************************	TITLE						
SIGNATURE	1+201		DATE10/04/2011						

(This space for State use only)

RECEIVED

OCT 1 2 2011

NEWFIELD PRODUCTION COMPANY - CASING & CEMENT REPORT

			8 5/8"	CASING SET AT	г	506.37	-		
LAST CASING DATUM DATUM TO CUT DATUM TO BRA TD DRILLER HOLE SIZE	13 OFF CASIN DENHEAD	NG FLANGE LOGG	13	- -	WELL	CONDOR OSPECT	R TRUST 12 Monumen		Company
LOG OF CASING	3 STRING:								
PIECES	OD	ITEM - M	IAKE - DESC	CRIPTION	WT/FT	GRD	THREAD	CONDT	LENGTH
1		wellhead						A	1.42
7	8 5/8"		oe jt 45.78)		24	J-55	STC	A	493.05
1		guide shoe			 			A	0.9
							1	· · · · · · · · · · · · · · · · · · ·	
			1100						
							1		
							1		· · · · · · · · · · · · · · · · · · ·
							1		1
							1		
					†		†	H	1
CASING INVENT	ORY BAL.		FEET	JTS	TOTAL LE	NGTH OF S	STRING		495.37
TOTAL LENGTH	OF STRING	G	495.37	11	-1	OFF PIEC			2
LESS NON CSG.	. ITEMS		2.32		PLUS DAT	UM TO T/C	OUT OFF CS	G	13
PLUS FULL JTS.		-	0		-	ET DEPTH			506.37
	TOTAL		493.05	11	1				
TOTAL CSG. DE	L. (W/O TH	RDS)				ARE .			
	TIMING				1				
BEGIN RUN CSC	 3.	Spud	9:00 AM	9/30/2011	GOOD CIR	C THRU J	OB '	Yes	
CSG. IN HOLE			5:00 AM		₹		URFACE !		
BEGIN CIRC			12:40 PM		RECIPROC			-	
BEGIN PUMP CN	MT		12:49 PM		-				
BEGIN DSPL. CN			1:07 PM		BUMPED F	LUG TO	450		

1:17 PM

10/4/2011

PLUG DOWN

		• • • • • • • • • • • • • • • • • • • 			· · · · · · · · · · · · · · · · · · ·				
CEMENT USED		CEMI	ENT COMPANY-	BJ					
STAGE	# SX	CEMI	ENT TYPE & ADDITIV	ES					
1	250	Class "G"+2%CaCl Mixed@ 15.8ppg W/1.17 yield returned 9bbls to pit							
				·					
	<u> </u>								
	<u> </u>								
				· · · · · · · · · · · · · · · · · · ·					
	l								
CENTRALIZER	& SCRATCI	HER PLACEMENT		SHOW MAKE & SPACIN	IG				
Middle of first,	top of seco	and third for a total of the	rree.						
COMPANY REP	RESENTAT	IVE Branden Arno	ld	DATE	10/4/2011 ⁻				

OPERATOR: NEWFIELD PRODUCTION COMPANY ADDRESS: RT. 3 BOX 3630

OPERATOR ACCT. NO.

N2695

MYTON, UT 84052

ACTION	CURRENT	NEW	1 4514444555									
CODE	ENTITY NO.	ENTITY NO.	API NUMBER	WELL NAME	QQ SC IP RG				COUNTY	SPUD DATE	EFFECTIVE	
В	99999	17400	4301350635	GMBU N-4-9-16	NESW	4		16E	DUCHESNE	10/3/2011	10/14/11	
WELL 1 C	OMMENTS:									10/0/2011	10/11/11	
10700	GRRV	·		BHL= SW	NW						1,000	
ACTION CODE	CURRENT ENTITY NO	NEW ENTITY NO.	API NUMBER	WELL NAME	QQ	WE SC	LL LOCAT		т	SPUD	EFFECTIVE	
В	99999	17400	4301350634	GMBU M-4-9-16	NESW	4	9S	RG 16E	DUCHESNE	10/4/2011	10/14/11	
ACTION	GREV			BHL= SI	UNE						and the second s	
ACTION CODE	CURRENT ENTITY NO	NEW ENTITY NO.	API NUMBER	WELL NAME	वस	SC	WELL	NOTABC BH	COUNTY	SPUD DATE	EFFECTIVE	
A	99999	18259	4301350903	CONDOR TRUST 12-18-4-1W	NWSW	18	48	1W	DUCHESNE	9/30/2011	10/14/11	
	GRRV CONFIDENTIAL											
ACTION CODE	CURRENT ENTITY NO.	NEW ENTITY NO	API NUMBER	WELL NAME	ଘପ	sc	WELL LO	CATION	COUNTY	SPUD DATE	EFFECTIVE	
В	99999	17400	4301350695	GMBU X-34-8-16	NWNW	03	95	16E	DUCHESNE	10/1/2011	10/14/11	
	GRRV			BHL Sec 3	4 78		y-'	ESI				
ACTION CODE	CURRENT ENTITY NO	NEW ENTITY NO.	API NUMBER	WELL NAME	aa	sc	WELL LO	CATION RG	COUNTY	SPUD DATE	EFFECTIVE	
В	99999	17 4 00	4301350694	GMBU U-33-8-16	NWNW	03 38	95 35		DUCHESNE	9/29/2011	10/14/11	
	GRRV			BH = Sec	337	85	\tilde{c}	SES	SE			
ACTION	CURRENT ENTITY NO	NEW ENTITY NO.	API NUMBER	WELL NAME	QQ T	sc	WELL LO	CATION RG	COUNTY	SPUD	EFFECTIVE	
А	99999	18260	4301350876	CONDOR TRUST 6-17-4-1W	NENW	17	48		DUCHESNE	9/28/2011	10/14/11	
(JRRV	W-9-01	·	BHL= SE	NW	····				CONFID	ENTIAL	
A-)r B-/w C-îro	DDES (See Instructions on bac new entity for new well (single w well to existing entity (group or u mane existing entity to anothe	reli only) mit well) r existing entity		RECEIVED				Signature	1	Jentri Park		
	ell from one existing entity to a er (explain in comments section			OCT 0 6 2011	Production Clerk-		10/06/11					

Sundry Number: 22162 API Well Number: 43013509030000

	STATE OF UTAH		FORM 9	
	DEPARTMENT OF NATURAL RESOURCES DIVISION OF OIL, GAS, AND MINII		5.LEASE DESIGNATION AND SERIAL NUMBER: Fee	
SUNDR	RY NOTICES AND REPORTS O	N WELLS	6. IF INDIAN, ALLOTTEE OR TRIBE NAME:	
	oposals to drill new wells, significantly de reenter plugged wells, or to drill horizont n for such proposals.		7.UNIT or CA AGREEMENT NAME:	
1. TYPE OF WELL Oil Well			8. WELL NAME and NUMBER: CONDOR TRUST 12-18-4-1W	
2. NAME OF OPERATOR: NEWFIELD PRODUCTION CO	DMPANY		9. API NUMBER: 43013509030000	
3. ADDRESS OF OPERATOR: Rt 3 Box 3630 , Myton, UT		HONE NUMBER: Ext	9. FIELD and POOL or WILDCAT: UNDESIGNATED	
4. LOCATION OF WELL FOOTAGES AT SURFACE: 1980 FSL 0571 FWL			COUNTY: DUCHESNE	
QTR/QTR, SECTION, TOWNSH Qtr/Qtr: NWSW Section:	an: U	STATE: UTAH		
11. CHEC	K APPROPRIATE BOXES TO INDICATE	NATURE OF NOTICE, REPOR	RT, OR OTHER DATA	
TYPE OF SUBMISSION		TYPE OF ACTION		
	ACIDIZE	ALTER CASING	CASING REPAIR	
NOTICE OF INTENT Approximate date work will start:	CHANGE TO PREVIOUS PLANS	CHANGE TUBING	CHANGE WELL NAME	
	CHANGE WELL STATUS	COMMINGLE PRODUCING FORMATIONS	CONVERT WELL TYPE	
SUBSEQUENT REPORT Date of Work Completion:	DEEPEN	FRACTURE TREAT	NEW CONSTRUCTION	
	OPERATOR CHANGE	PLUG AND ABANDON	PLUG BACK	
SPUD REPORT	✓ PRODUCTION START OR RESUME	RECLAMATION OF WELL SITE	RECOMPLETE DIFFERENT FORMATION	
Date of Spud:	☐ REPERFORATE CURRENT FORMATION ☐ SIDETRACK TO REPAIR WELL		TEMPORARY ABANDON	
✓ DRILLING REPORT	L_ TUBING REPAIR L	VENT OR FLARE	☐ WATER DISPOSAL ☐	
Report Date: 11/15/2011	L WATER SHUTOFF	SI TA STATUS EXTENSION	APD EXTENSION	
	WILDCAT WELL DETERMINATION	OTHER	OTHER:	
The above well w	completed operations. Clearly show all vas placed on production on 1 hours.	1/15/2011 at 16:00	Accepted by the Utah Division of Oil, Gas and Mining FOR RECORD ONLY January 13, 2012	
NAME (PLEASE PRINT) Jennifer Peatross	PHONE NUMBE 435 646-4885	TITLE Production Technician		
SIGNATURE N/A		DATE 1/13/2012		
13/ <i>1</i> 7		1/10/2012		

Form 3160-4 (August 2007)

UNITED STATES DEPARTMENT OF THE INTERIOR BUREAU OF LAND MANAGEMENT

CONFIDENTIAL

FORM APPROVED OMB NO. 1004-0137 Expires: July 31, 2010

WELL COMPLET	ION OR RECOMPL	ETION DEDODT	ANDLOG
WELL CUMPLE	ION OR RECUIRE	LETION KEPUKT	AND LUG

	VV	ELL C	OWIPL	EIIO	NURF	RECOMPLE	HOR	NEPORI	ANDI	LOG			FEE		eriai No.		
la. Type of b. Type of	Well Completion		l Well	☐ Ga	as Well ork Over	Dry Deepen	Othe Plug	er Back Di	f. Resvr.	.,					, Allottee or		
			her:					_					7. Uı	nit or (CA Agreeme	nt Name	and No.
2. Name of NEWFIEL	Operator D EXPLOR	RATION	СОМІ	PANY											ame and Wel		1W
3. Address	1401 17TH S	ST. SUITE	1000 DE	NVER, CO	O 80202			3a. Phone (435) 64		lude ar	ea code)		FI Wel			
4. Location			-			lance with Federa	l requ	, ,					10. F	Field a	nd Pool or Ex	plorator	<u>y</u>
At surfac	e 1090' E	21 9 57	4' E\A/I	(NIM//C	M/V SEC	. 18, T4S, R1W	,						11 \$	lec T	NATED ., R., M., on I	Block an	d
	1900 13	3L & 31	1 F VVL	(1444/3	W) SEC	. 10, 143, KIW	•						s	urvey	or Area SEC	. 18, T4S	, R1W
At top pro	od. interval r	eported b	oelow												or Parish		State
At total de	epth 7380'	ı											DUC	HES	NE	บา	Γ
14. Date Sp 09/30/201				Date T.I	D. Reache	d		16. Date Com			2011 to Prod.				ons (DF, RK 5195' KB	B, RT, C	GL)*
18. Total D	epth: MD	7380		1201201		•		7326'	<u>√</u> 1			idge Plug	g Set:	MD	3193 KB		
	TVI lectric & Oth		pical Lo	es Run (Submit co		VD			22. V	Was well	cored?	Z No	ΓVD ο Γ	Yes (Subm	it analysi	s)
DUAL INC	GRD, SP	, COMP	P. DEN	SITY,C	OMP. N	EUTRON,GR,0	ALIF	PER, CMT BO	ND		Was DST	run? al Survey	/? 	。	Yes (Subm Yes (Subm	it report)	
23. Casing	and Liner R	Record (1	Report a	ll strings	set in wei	(1)								<u> </u>	i res (suom	. сору)	
Hole Size	Size/Gra	ade V	Vt. (#/ft.)	To	p (MD)	Bottom (MD)	۱ ا	Stage Cementer Depth		of Sks of Ce		Slurry (BI	/ Vol. BL)	Cer	nent Top*	A	mount Pulled
12-1/4"	8-5/8" J-		4#	0		505'				CLASS							
7-7/8"	5-1/2" J-	55 1	5.5#	0		7369'				RIML				203'	~ has		
	-			-			+		485 5	60/50 F	POZ						_
	<u> </u>			+			+										
				†			+										
24. Tubing Size		Set (MD)	Pagi	ker Depth	(MD)	Size	-	Depth Set (MD)	Dookon	Depth	(MD) I	Siz		Dor	oth Set (MD)	l De	acker Depth (MD)
2-7/8"		7116'		6952'	i (ivii)	Size	1	beput Set (MD)	Facker	Depui	(MD)	312	20	Dej	our set (MD)	FZ	icker Depui (MD)
25. Produci	ing Intervals			To		Bottom	26.					11-0	l No II	Ialaa		Dowf (C4_4
A) Wasato		11	1	7214'	ų di	7217'	52	Perforated Interval Size 5226-7217' .34"			No. Holes Perf. Status 57						
B) Green	River			5226'		6985'											
C) D)							-	· · · · · · · · · · · · · · · · · · ·			ļ						
	racture, Trea	atment (ement S	meeze	etc						<u> </u>		<u> </u>	·			
	Depth Inter		omon c	rqueeze,	cic.				Amount	and Ty	pe of M	laterial					
5226-721	7'		F	rac w/	282590#	£ 20/40 white sa	and i	n 2069 bbls L	ightning	17 flu	uid, in 5	5 stage:	S.				
			_														
28. Product			hr		0.1		3 7	b:: c	,	- In		Б	3.4				
Produced	Test Date	Hours Tested	Test Prod		Oil BBL		Water BBL	Oil Gra Corr. A		Ga Gr	avity		duction M 1/ 2" x 1 -3		20' x 21' x	24' RH/	AC Pump
11/18/11	11/29/11	24	-	▶	45	34	30										•
Choke Size	Tbg. Press. Flwg.	Csg. Press.	24 H Rate		Oil BBL		Water BBL	Gas/Oi Ratio	1	- 1	ell Statu						
Size	SI	r iess.	Rate		DDL	MCF	DDL	Katio			RODU	CING					
28a. Produc	tion - Interv	val B															
Date First		Hours	Test		Oil		Water			Ga		Proc	duction M	ethod			
Produced		Tested	-rod	uction	BBL	MCF I	BBL	Corr. A	L1	Gr	avity				F	REC	EIVED
Choke Size	Tbg. Press. Flwg.	Csg. Press.	24 H Rate		Oil BBL		Water BBL	Gas/Oi Ratio	1	W	ell Statu	ıs			-	APR (9 2012
*(See inst	SI ructions and	spaces f	or additi	onal date	on page	2)									DIV. OF	OIL. (SAS & MINING
,		-F 2000 I			. J Page	-,										-, -	~ with All AC

										·	
	uction - Inte	****	—	10		L		- .			
Date First Produced	Test Date	Hours Tested	Test Production	Oil BBL	Gas MCF	Water BBL	Oil Gra Corr. A		Gas Gravity	Production Method	
Troduced		Colou	Toddetion	BBC	IVICI	BBC	Con. A	u i	Gravity		
Choke	Tbg. Press.	Con	24 Hr.	Oil	Gas	Water	Gas/Oi	1	Well Status		
Size		Press.	Rate	BBL	MCF	Water BBL	Ratio	<u> </u>	wen Status		
	SI										
28c Produ	L action - Inte	rval D									
Date First		Hours	Test	Oil	Gas	Water	Oil Gra	vity	Gas	Production Method	· · · · · · · · · · · · · · · · · · ·
Produced		Tested	Production	BBL	MCF	BBL	Corr. A	νPI .	Gravity		
			-				1		İ		
Choke	Tbg. Press.		24 Hr.	Oil	Gas	Water	Gas/Oi	1	Well Status		
Size	Flwg. SI	Press.	Rate	BBL	MCF	BBL	Ratio				
29. Dispos	sition of Gas	s (Solid, us	ed for fuel, ve	ented, etc.,)						
	USED FOR F										
30. Summ	nary of Poro	us Zones (Include Aqu	ifers):					31. Formatio	on (Log) Markers	
Show a	ıll important	zones of p	orosity and c	ontents th	ereof: Cored	intervals and al	ll drill-stem	tests.	0501.001	CAL MADIZEDO	
includi	ng depth int	erval tested	l, cushion use	ed, time to	ol open, flowi	ing and shut-in	pressures a	nd	GEOLOGI	CAL MARKERS	
recover	ries.										
											Тор
Form	nation	Top Bottom			Des	criptions, Cont	ents, etc.			Name	Meas. Depth
		ļ	 								weas. Deput
WASATCH GREEN RIV		7214' 5226'	7217' 6985'						GARDEN GUI	LCH MARKER	4617' 4828'
OILLIAM	ZEN	JEZO	0903						GARDEN GUI	LON I	4020
									GARDEN GUI POINT 3 MAR		4959' 5256'
									POINT 3 MAN	RACK	5256
									X MRKR		5485' 5519'
									Y MRKR		2019
		ļ							DOUGLAS CE		5644'
		İ							BI-CARBONA	NIE.	5953'
				Ì					B LIMESTON CASTLE PEA		6088' 6546'
									ONOTELTER		0040
									BASAL CARB WASATCH	ONATE	6913' 7068'
				ļ					11,10,110,1		1,555
		ŀ	:								
22 Addit	ional remark	ka (inaluda	plugging pro	oodima);							
32. Addit	ionai iemair	ks (include	bingging bro	cedure):							
33 Indica	te which ite	ms have h	en attached l	hy placing	a check in the	e appropriate b	ooxes.				
						_				_	
☐ Elec	ctrical/Mecha	anical Logs	(1 full set req	'd.)		Geologic Repo	ort i	DST Re	port	☐ Directional Survey	
Sun	dry Notice fo	or plugging	and cement v	erification		Core Analysis	s	✓ Other: [Drilling Daily	Activity	
34. I here	by certify th	at the fore	going and att	ached info	ormation is co	mplete and con	rect as deter	rmined fron	n all available r	ecords (see attached instructions)	*
		_	nifer Peat			•			n Technician		
			Matr	XL			_				
S	ignature	$\rightarrow \downarrow \downarrow$		V			Date 0	1/04/2012	<u> </u>		
		()					 				
						it a crime for a			and willfully to	make to any department or agend	by of the United States any

(Continued on page 3) (Form 3160-4, page 2)

Daily Activity Report

Format For Sundry CONDOR TRUST 12-18-4-1W 8/1/2011 To 12/30/2011

CONDOR TRUST 12-18-4-1W

Waiting on Cement

Date: 10/4/2011

Ross #26 at 506. Days Since Spud - yield. Returned 9bbls to pit, bump plug to 450psi, BLM and State were notified of spud via email. - 506.37'KB. On 10/4/11 cement w/BJ w/250 sks of class G+2%kcl+.25#CF mixed @ 15.8ppg and 1.17 - On 9/30/11 Ross #29 spud and drilled 505' of 12 1/4" hole, P/U and run 11 its of 8 5/8" casing set

Daily Cost: \$0

Cumulative Cost: \$107,336

CONDOR TRUST 12-18-4-1W

Wait on daylight

Date: 10/15/2011

Capstar #328 at 506. 3 Days Since Spud - Wait on daylight

Daily Cost: \$0

Cumulative Cost: \$107,336

CONDOR TRUST 12-18-4-1W

Drill 7 7/8" hole with fresh water

Date: 10/16/2011

Capstar #328 at 1523. 1 Days Since Spud - Drill out f/447' - 506' - TIH and tag cement @ 447' - M/U bit, P/U and orientate directional tools, P/U BHA - Test BOP - Wait on testers, strap BHA - Move rig 3.0 miles from CT 6-17-4-1W - Rig down, wait on daylight to move - Drill 7 7/8" hole f/506' - 1,523' 14 WOB, 190 TRPM, 6,700 TRQ, 1,220 PP, 420 GPM - N/U BOP - Rig accepted @ 11:00 on 10/15/2011

Daily Cost: \$0

Cumulative Cost: \$183,770

CONDOR TRUST 12-18-4-1W

Drill 7 7/8" hole with fresh water

Date: 10/17/2011

Capstar #328 at 4195. 2 Days Since Spud - Drill 7 7/8" hole f/1,523' - 2,927' 22 WOB, 185 TRPM, 8,000 TRQ, 1,400 PP, 420 GPM - Rig Service - Drill 7 7/8" hole f/2,927' - 4,195' 22 WOB, 185 TRPM, 8,000 TRQ, 1,400 PP, 420 GPM

Daily Cost: \$0

Cumulative Cost: \$203,835

CONDOR TRUST 12-18-4-1W

Drill 7 7/8" hole with fresh water

Date: 10/18/2011

Capstar #328 at 5962. 3 Days Since Spud - Rig Service - Drill 7 7/8" hole f/4,195' - 4,965' 18 WOB, 160 TRPM, 7,000 TRQ, 1,400 PP, 375 GPM - Drill 7 7/8" hole f/4,965' - 5,962' 19 WOB, 185 TRPM, 7,000 TRQ, 1,500 PP, 430 CPM

185 TRPM, 7,000 TRQ, 1,500 PP, 420 GPM

Daily Cost: \$0

Cumulative Cost: \$225,700

CONDOR TRUST 12-18-4-1W

TOOH

Date: 10/19/2011

Capstar #328 at 7380. 4 Days Since Spud - Pump slug and TOH for wireline logs - Drill 7 7/8" hole f/6,731' - 7,380' 24 WOB, 190 TRPM, 6,300 TRQ, 1,500 PP, 420 GPM - Circulate bottoms

up, check for flow - no flow - Drill 7 7/8" hole f/5,962' - 6,731' 24 WOB, 190 TRPM, 6,300

TRQ, 1,500 PP, 420 GPM - Rig Service

Daily Cost: \$0

Cumulative Cost: \$342,698

CONDOR TRUST 12-18-4-1W

Nipple down

Date: 10/20/2011

Capstar #328 at 7380. 5 Days Since Spud - PJSM, R/U PSI, and run wireline logs - TOH for wireline logs - PJSM, R/U and run 176 jts 5.5" J-55 15.5# casing set @ 7,368.97'. Picked up 43.3' jt to tag with, - laid down, P/U Cameron mandrel & landing jt, land casing (176 jts + mandrel). Transfer 8 joints + - landing jt to Abegglen 6-18-4-1W - PJSM and pump cement - 290 sx lead, 485 sx tail, 25 bbl to surface - Nipple down and clean tanks - Circulate casing while R/U BJ cementers

Daily Cost: \$0

Cumulative Cost: \$405,405

CONDOR TRUST 12-18-4-1W

Wait on Completion

Date: 10/21/2011

Capstar #328 at 7380. 6 Days Since Spud - Nipple down and clean tanks - Rig released @

06:30 on 10/20/2011 Finalized

Daily Cost: \$0


Cumulative Cost: \$405,685

Pertinent Files: Go to File List

Sundry Number: 29026 API Well Number: 43013509030000

	STATE OF UTAH		FORM 9				
ı	DEPARTMENT OF NATURAL RESOURCES DIVISION OF OIL, GAS, AND MINING	3	5.LEASE DESIGNATION AND SERIAL NUMBER: Fee				
SUNDR	Y NOTICES AND REPORTS ON	WELLS	6. IF INDIAN, ALLOTTEE OR TRIBE NAME:				
Do not use this form for pro current bottom-hole depth, I FOR PERMIT TO DRILL form	posals to drill new wells, significantly deep reenter plugged wells, or to drill horizontal n for such proposals.	pen existing wells below laterals. Use APPLICATION	7.UNIT or CA AGREEMENT NAME:				
1. TYPE OF WELL Oil Well			8. WELL NAME and NUMBER: CONDOR TRUST 12-18-4-1W				
2. NAME OF OPERATOR: NEWFIELD PRODUCTION CO	DMPANY		9. API NUMBER: 43013509030000				
3. ADDRESS OF OPERATOR: 1001 17th Street, Suite 200		ONE NUMBER: 3 382-4443 Ext	9. FIELD and POOL or WILDCAT: UNDESIGNATED				
4. LOCATION OF WELL FOOTAGES AT SURFACE: 1980 FSL 0571 FWL			COUNTY: DUCHESNE				
QTR/QTR, SECTION, TOWNSH Qtr/Qtr: NWSW Section:	IIP, RANGE, MERIDIAN: 18 Township: 04.0S Range: 01.0W Meridian	n: U	STATE: UTAH				
11. CHECI	K APPROPRIATE BOXES TO INDICATE N	ATURE OF NOTICE, REPOR	T, OR OTHER DATA				
TYPE OF SUBMISSION		TYPE OF ACTION					
_	ACIDIZE	ALTER CASING	CASING REPAIR				
NOTICE OF INTENT Approximate date work will start:	CHANGE TO PREVIOUS PLANS	CHANGE TUBING	CHANGE WELL NAME				
	CHANGE WELL STATUS	COMMINGLE PRODUCING FORMATIONS	CONVERT WELL TYPE				
SUBSEQUENT REPORT Date of Work Completion: 3/1/2012	DEEPEN I	FRACTURE TREAT	☐ NEW CONSTRUCTION				
	OPERATOR CHANGE	PLUG AND ABANDON	PLUG BACK				
SPUD REPORT	PRODUCTION START OR RESUME	RECLAMATION OF WELL SITE	RECOMPLETE DIFFERENT FORMATION				
Date of Spud:	REPERFORATE CURRENT FORMATION	SIDETRACK TO REPAIR WELL	TEMPORARY ABANDON				
_	TUBING REPAIR	VENT OR FLARE	WATER DISPOSAL				
DRILLING REPORT Report Date:	☐ WATER SHUTOFF ☐ :	SI TA STATUS EXTENSION	APD EXTENSION				
	☐ WILDCAT WELL DETERMINATION ✓	OTHER	OTHER: Site Facility/Site Security				
SEE ATT	COMPLETED OPERATIONS. Clearly show all per TACHED REVISED SITE FACILITY	rtinent details including dates, d	,				
NAME (PLEASE PRINT) Jill L Loyle	PHONE NUMBER 303 383-4135	TITLE Regulatory Technician					
SIGNATURE N/A		DATE 8/16/2012					

Sundry Number: 29026 API Well Number: 43013509030000

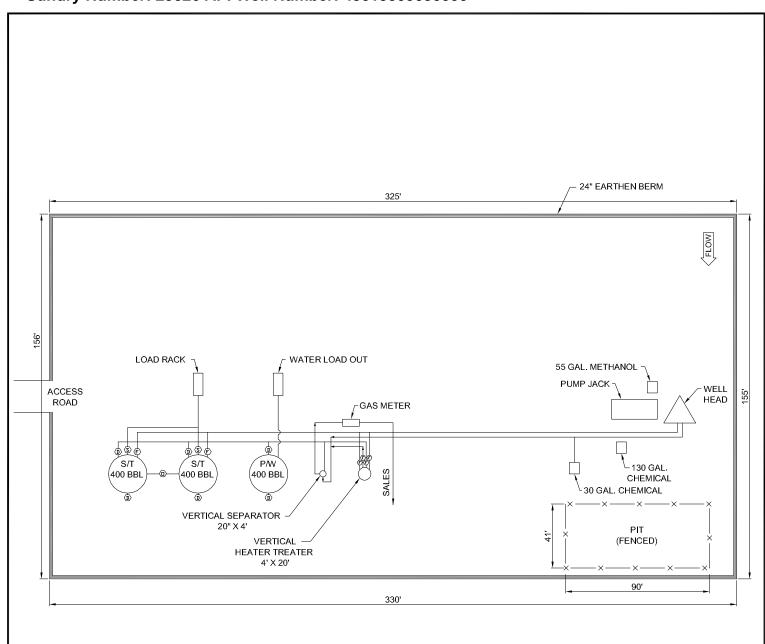

POSITION	ON OF VALVES AND	USE OF SEALS DUR	ING PRODUCTION	_ Va	alve Type	Federal Leas	a #· FFF			
Valve	Line Purpose	Position	Seal Installed		Orain Valve	API #: 4301350903				
D	Draln	Closed	Yes		low Valve	AFT#. 4501330903				
F	Oll, Gas, Water	Open	No		Overflow	This lease is subject to the				
0	Overflow	Open/Closed	No] v - i		Site Security Plan for:				
V	Vent	Open	No		Recycle	Newfield Exploration Company				
R	Recycle	Closed	Yes		Blow Down	19 East Pine Street				
В	Blowdown	Open/Closed	No		Sales Valve	Pinedale, WY 82941				
S	Sales	Closed	Yes	ت ا		Pinedale, W	1 82941			
POS	SITION OF VALVES A	ND USE OF SEALS D	URING SALES	POSITION OF VALVES AND USE OF SEALS DURING WATER DRAIN						
Valve	Line Purpose	Position	Seal Installed	Valve	Line Purpose	Position	Seal Installed			
D	Draln	Closed	Yes	D	Drain	Open	No			
F	Oil, Gas, Water	Closed	Yes	F	Oil, Gas, Wate	r Closed	No			
0	Overflow	Closed	Yes	0	Overflow	Closed	No			
V	Vent	Open	No	V	Vent	Open	No			
R	Recycle	Closed	Yes	R	Recycle	Closed	Yes			
В	Blowdown	Closed	No	В	Blowdown	Closed	No			
S	Sales	Open	No	S	Sales	Closed	Yes			



CONDOR TRUST 12-18-4-1W

Newfield Exploration Company NWSW Sec 18, T4S, R1W Duchesne County, UT

M.G. MAR 2012



Note: This drawing represents approximate sizes and distances. Underground plpellne locations are also approximated.